# DEVELOPMENT APPLICATION 142 LAMBETH STREET PANANIA





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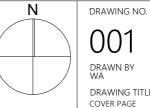
PROJECT ADDRESS 142 LAMBETH STREET PANANIA

PROJECT DESCRIPTION BOARDING HOUSE DEVELOPMENT

CLIENT MR S. METRY

STATUS DA

STAGE DEVELOPMENT APPLICATION



CHE WA DRAWING TITLE

EC	KED	B١



DATE 16/02/2023 SCALE 1:50@ A1 1:100@ A3

JOB NO.

PQ

# DEVELOPMENT APPLICATION 142 LAMBETH STREET PANANIA

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		UNIT AREA SCHEDULE - F	SA
COMPLIANCE DETAILS		ROOM NAME	AREA
		COMMERCIAL	73
Bankstown Local Enviromatal Plan 2015 / DCP Bankstown		COMMUNAL LIVING SPACE	51
		COMMUNAL SPACE	98
ZONE: B1		ROOM 01	24
		ROOM 02	23
LOT / SECTION / PLAN No. 3 / - / DP13772, 4 / - / DP13772		ROOM 03	23
LOT TYPE: Standard lot		ROOM 04	25
		ROOM 05	20
Basix number		ROOM 06	23
Dasix Humber		ROOM 07	22
		ROOM 08	23
Site Area: 446.6 m²		ROOM 09	21
		ROOM 10	20
Maximun building height – 11 m	yes	ROOM 11	20
		ROOM 12	20
Maximun wall height - 7 m		ROOM 13	22
5		ROOM 14	20
		ROOM 15	23
		ROOM16	20

	ISSUE DATE PURPOSE OF ISSUE	PROJECT ADDRESS 142 LAMBETH STREET PANANIA	STATUS DA	N	DRAWING NO.
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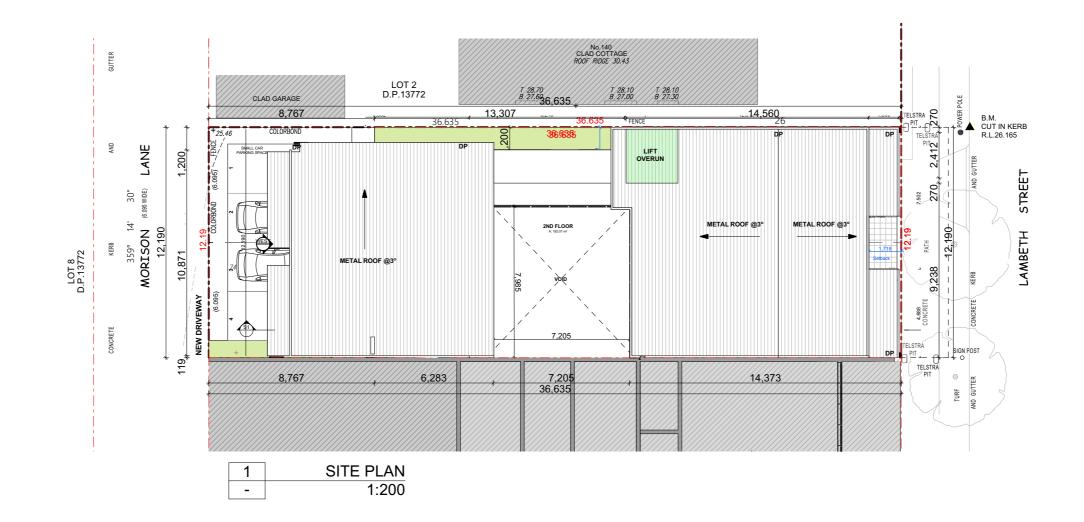
### Drawing List


Sheet No:	Sheet Name
001	COVER PAGE
002	GENERAL NOTES
101	SITE PLAN
102	DEMOLITION
103	GROUND FLOOR
104	FIRST FLOOR
105	SECOND FLOOR
106	ROOF PLAN
201	ELEVATION
202	ELEVATION
203	ELEVATION
204	MATERIAL SCHEDULE
301	SECTION
400	MARCH SHADOW
401	SHADOWS
402	PERSPECTIVE SHADOWS
403	SITE ANALYSIS
404	SEDIMENT & EROSION PLAN
405	Window Schedule
406	NOTIFICATION


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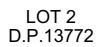



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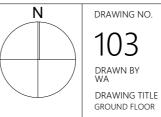
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PROJECT ADDRESS 142 LAMBETH STREET PANANIA

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PROJECT DESCRIPTION BOARDING HOUSE DEVELOPMENT

CLIENT MR S. METRY STAGE DEVELOPMENT APPLICATION

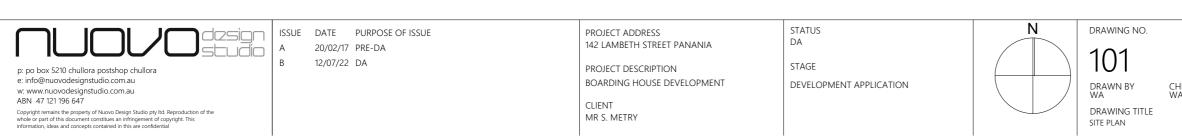

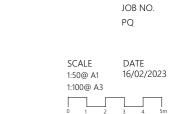

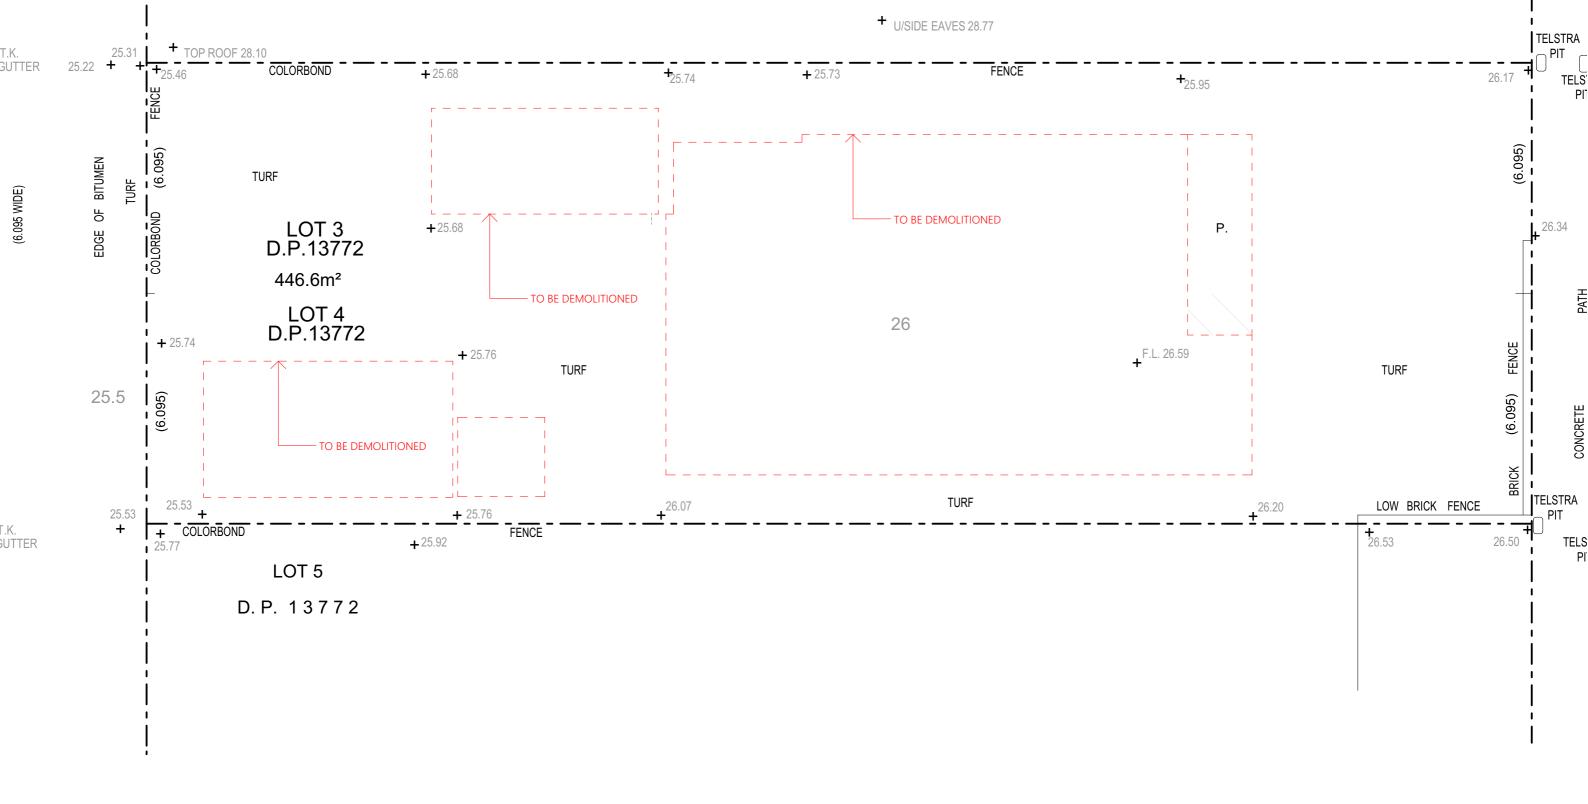

12.19

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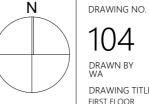
PROJECT DESCRIPTION BOARDING HOUSE DEVELOPMENT

STAGE

STATUS


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CLIENT MR S. METRY DEVELOPMENT APPLICATION




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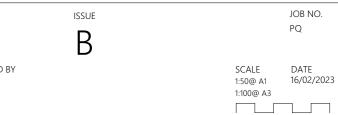






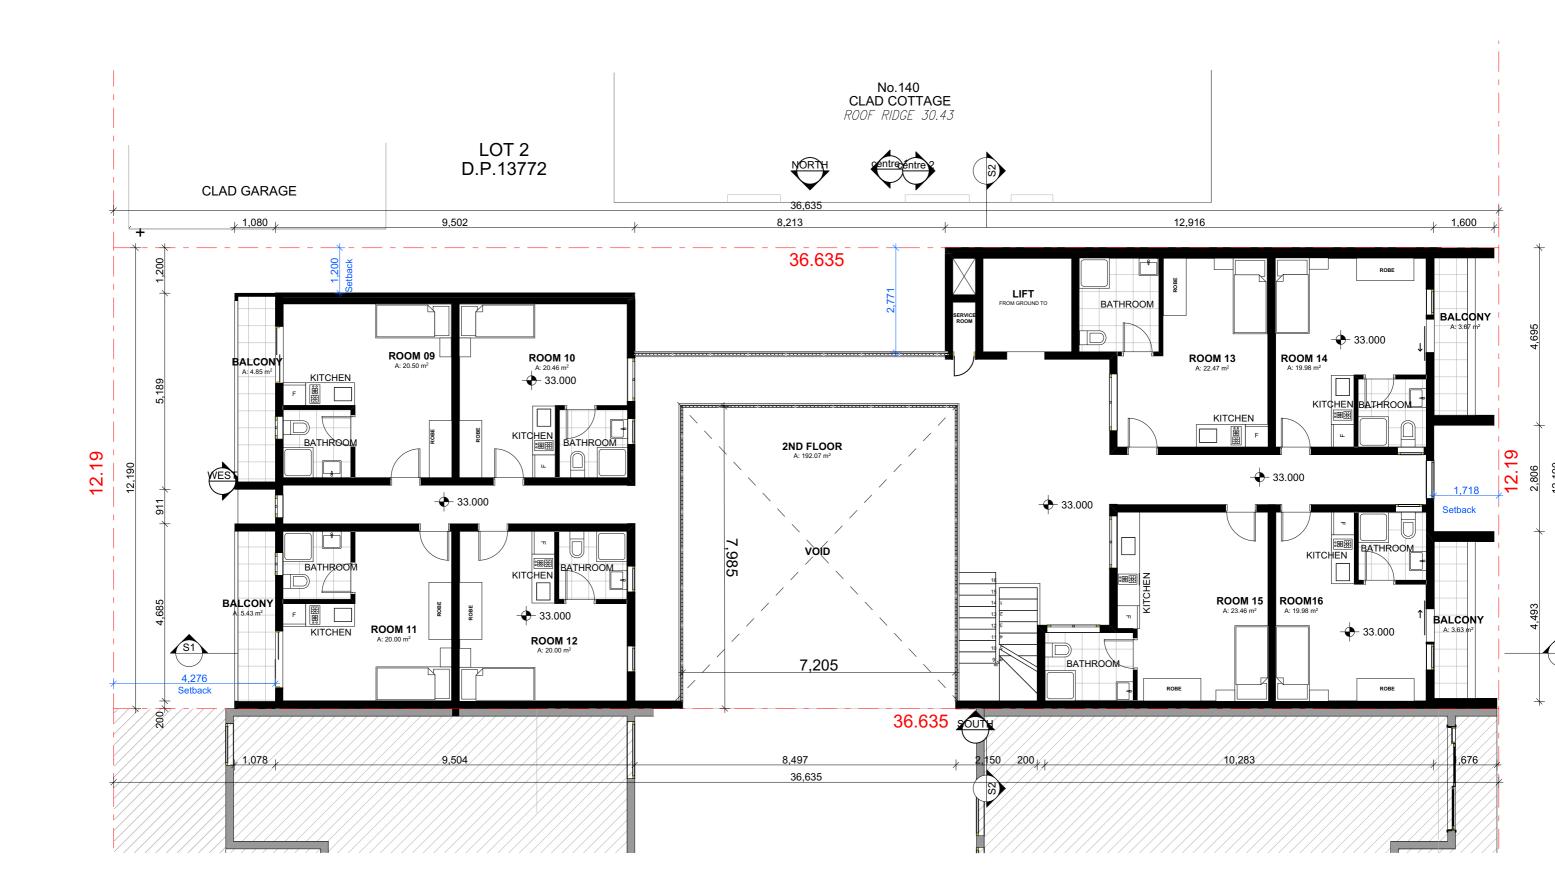




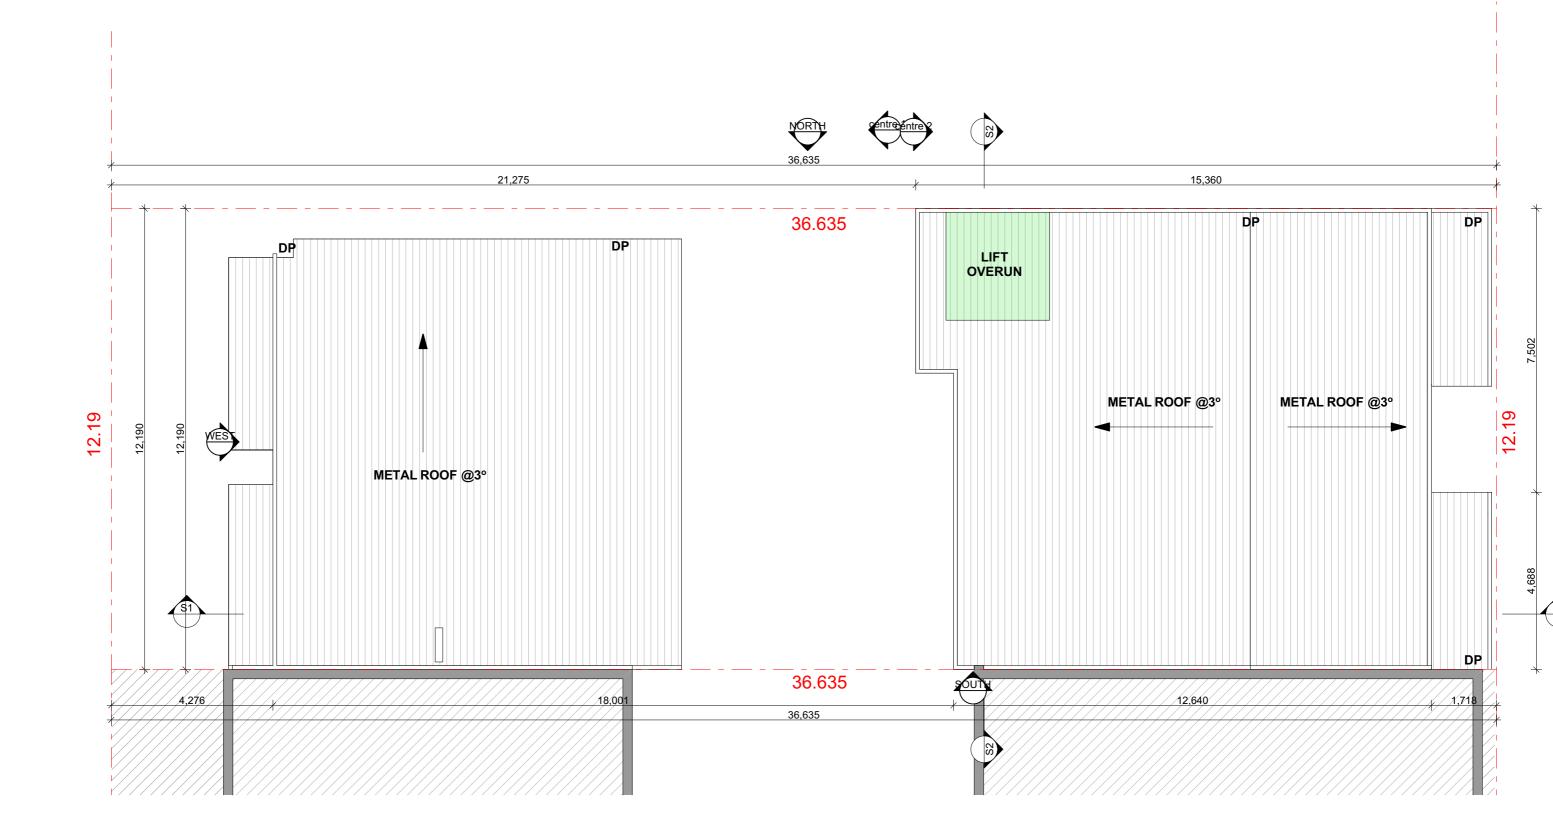







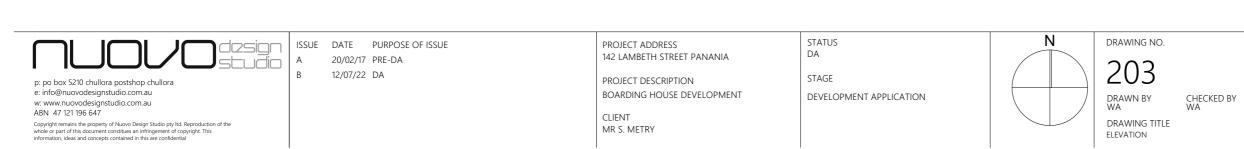



**Dulux**<sup>•</sup> B11 Lexicon® Quarter

## **R1**

WHITE RENDER



BLACK BRICK AND MORTAR



TIMBER CLADDING



BLACK CLADDING



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36.600

**R**<sup>′</sup>

142 LAMBETH STREET PANANIA

PROJECT ADDRESS

PROJECT DESCRIPTION BOARDING HOUSE DEVELOPMENT

CLIENT MR S. METRY

MAX BUILDING HEIGHT 11m

. .

**B1** 

**C**2

B1

**R1** 


BOUNDARY

26.15

R1

STATUS DA

STAGE DEVELOPMENT APPLICATION

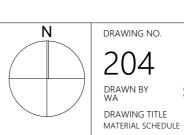










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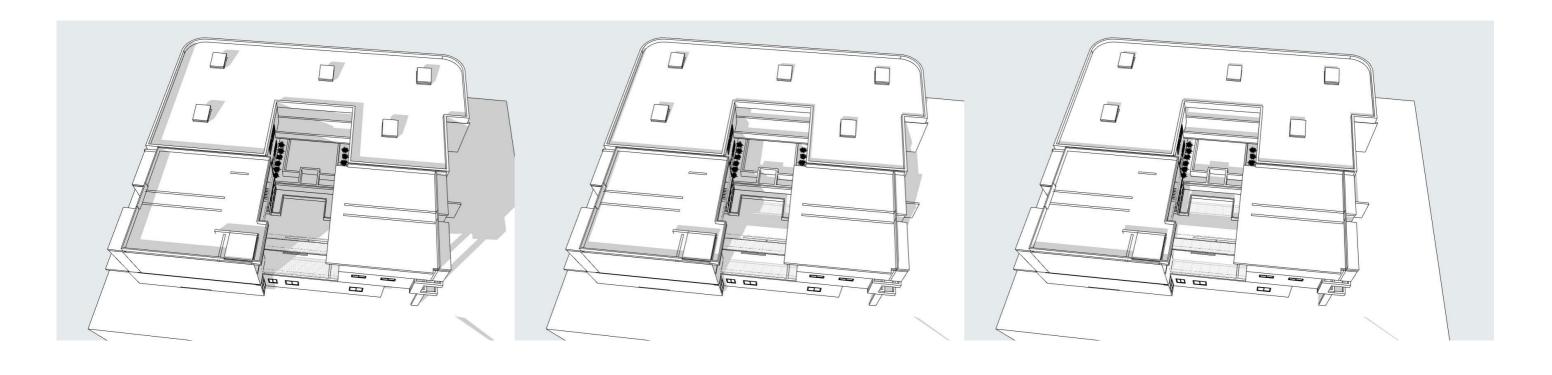
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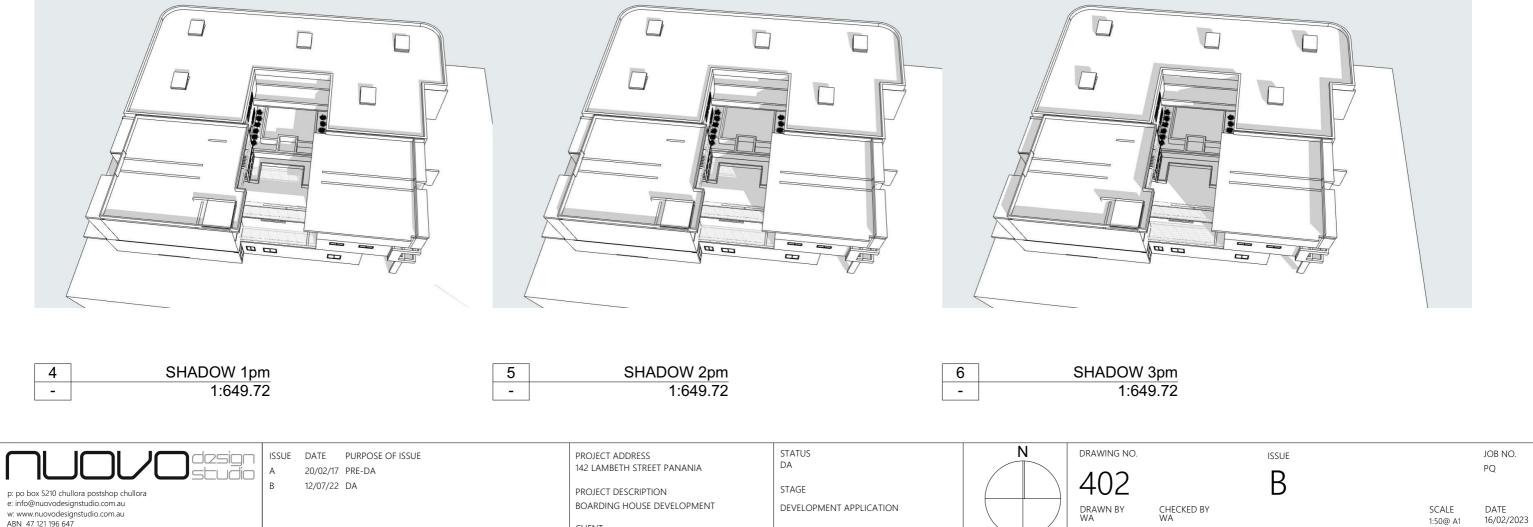
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1	SHADOW 9am	2	SHADOW 11am	3	SHADOW 12pm
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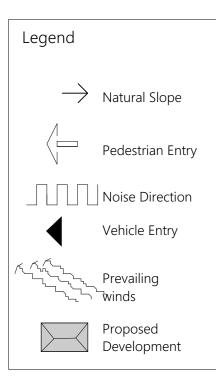
CLIENT MR S. METRY

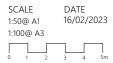


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PERSPECTIVE SHADOWS



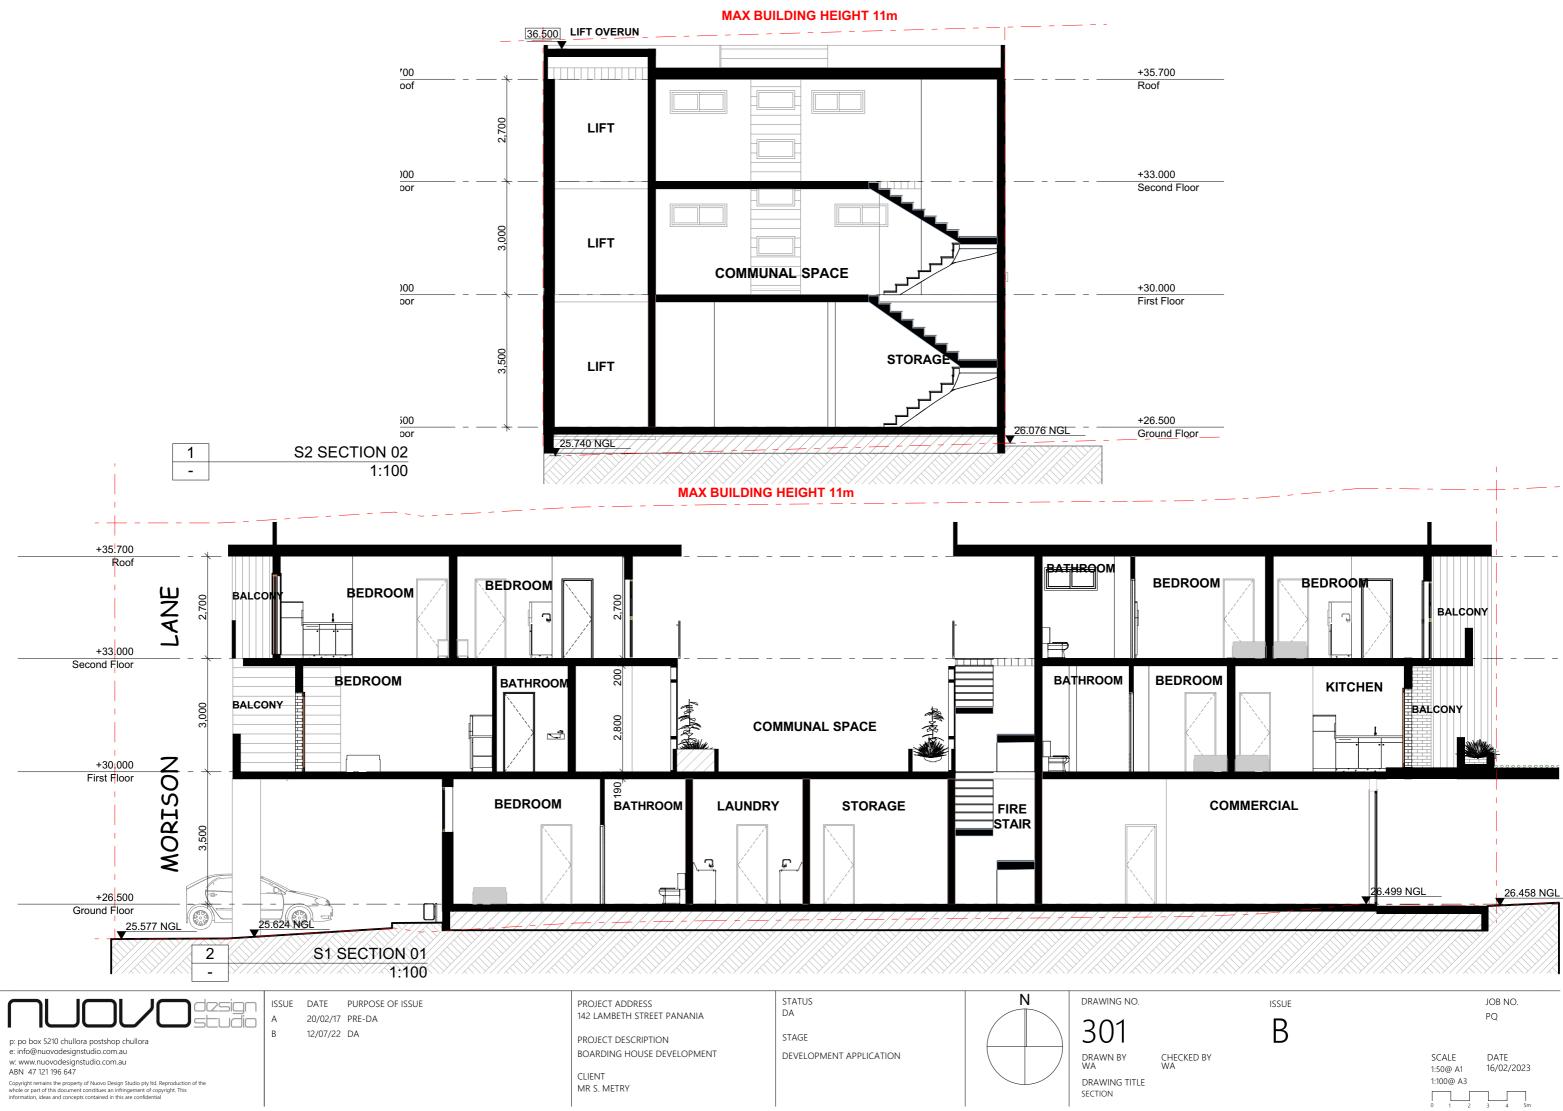

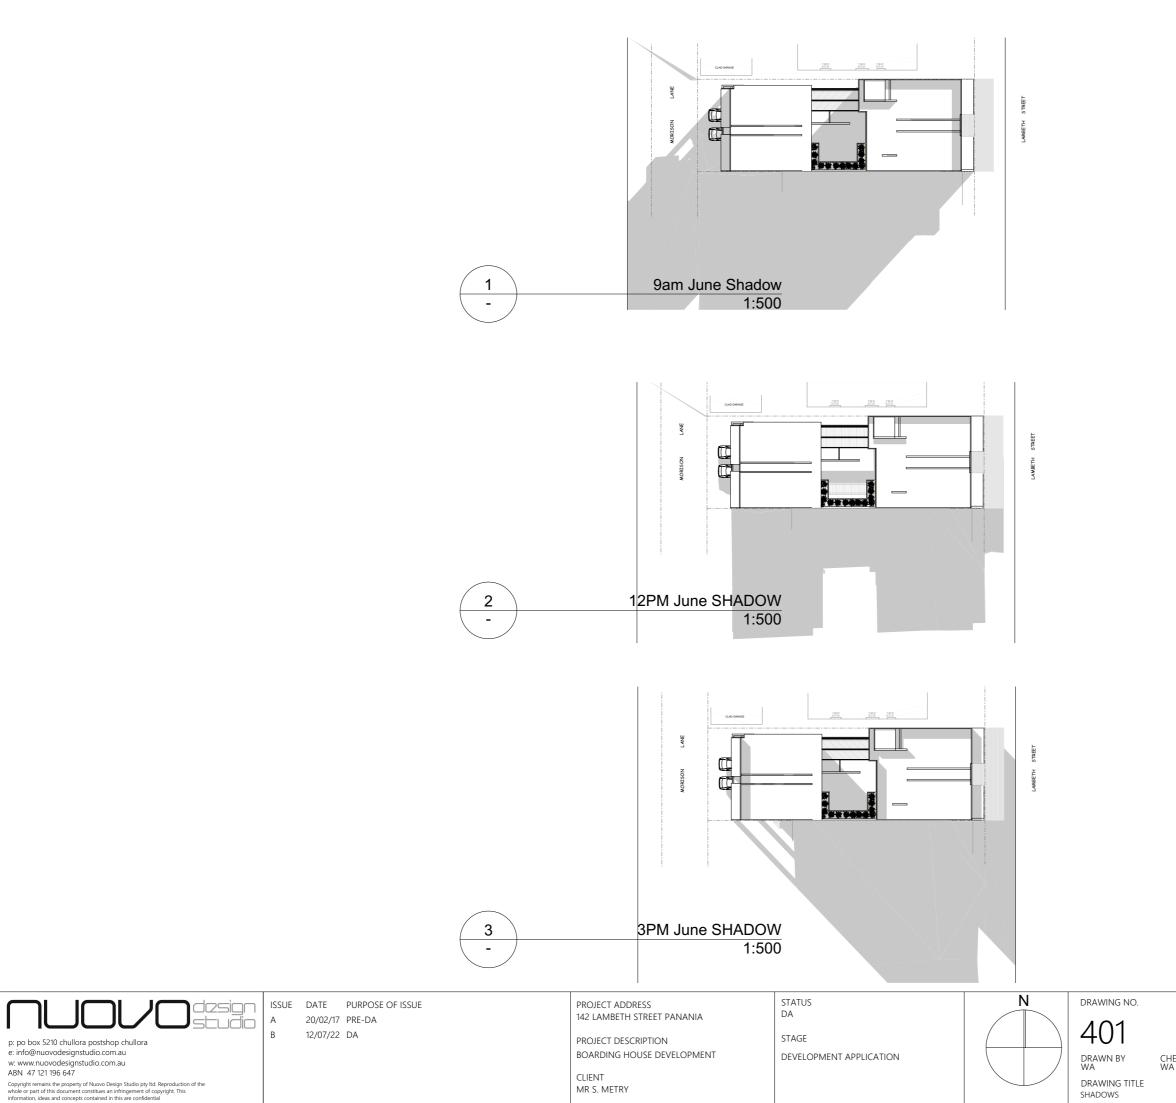
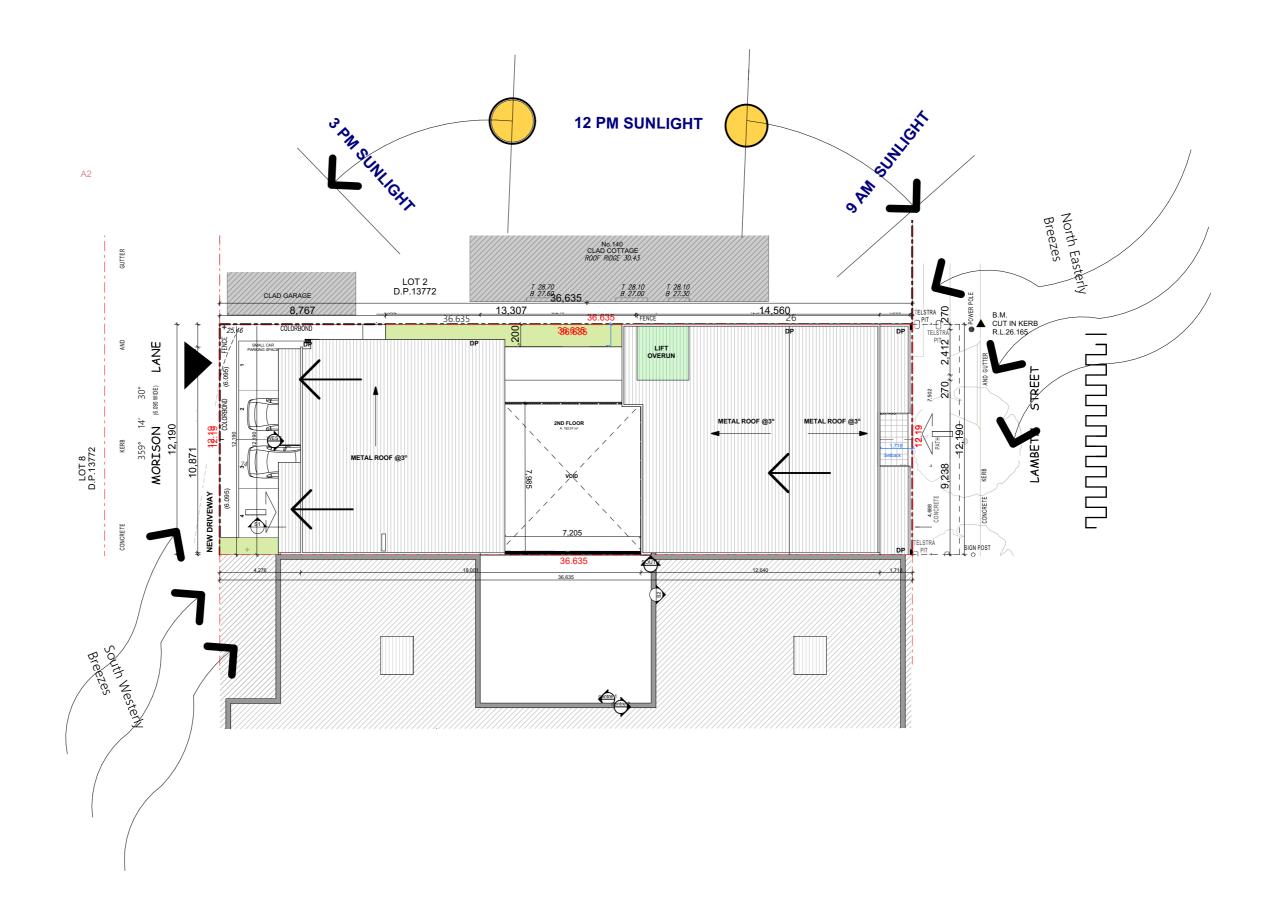
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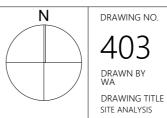
PROJECT DESCRIPTION


BOARDING HOUSE DEVELOPMENT

CLIENT MR S. METRY STAGE DEVELOPMENT APPLICATION

STATUS

DA



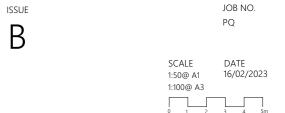


#### Legend

- Sediment Fencing
- Sediment Traps to drains




Stock Piling Area

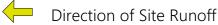

### Fall Of Site

SILT ARRESTOR PIT GENERAL NOTES 1. PITS TO BE CONSTRUCTED IN THE FOLLOWING MANNER 1.1 PRECAST 1.2 BRICKS WITH CEMENT RENDER 2. OUTLET PIPES TO BE PLACED AT 90 DEGREES TO THE INLET PIPELINE (AS SHOWN IN THE 3. INLET TO BE ABOVE SCREEN AND THE OUTLET TO BE BELOW THE SCREEN 4. ALL WORK TO BE THE SATISFACTION OF THE DIRECTOR TECHNICAL SERVICES 5. ORIFICE PLATES ARE NOT TO BE USED 6. FOR CONNECTION TO COUNCIL'S DRAINAGE SYSTEM 6.1 CONNECTION TO BE MADE INTO TOP ONE THIRD OF COUNCIL'S PIPE AT 45 DEGREES TO FLOW

6.2 ON PIPE PROTRUSAION ALLOWED INTO COUNCIL'S PIPELINE 6.3 INSPECTION TO BE MADE BY COUNCIL'S ENGINEER PRIOR TO THE SEALING OF THE

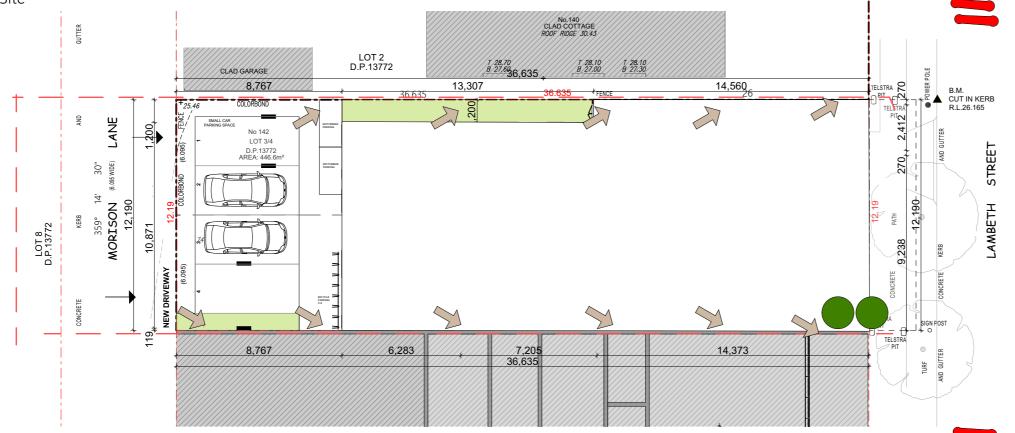



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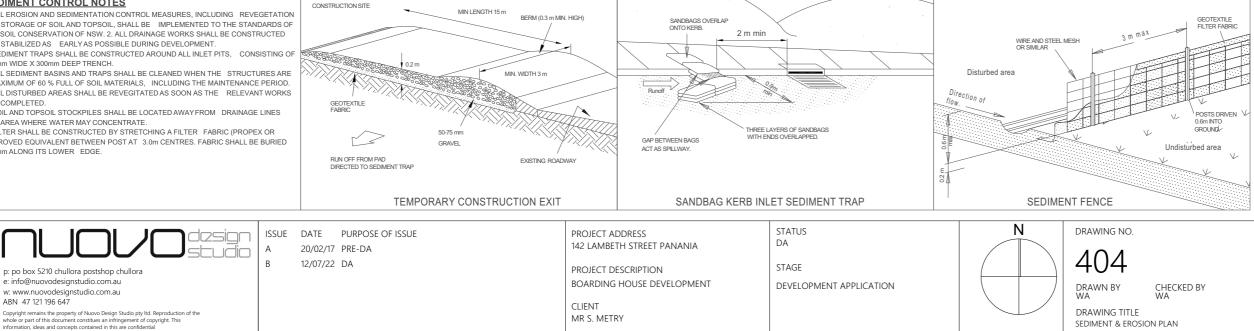
I. ALL EROSION AND SEDIMENTATION CONTROL MEASURES, INCLUDING REVEGETATION AND STORAGE OF SOIL AND TOPSOIL, SHALL BE IMPLEMENTED TO THE STANDARDS OF THE SOIL CONSERVATION OF NSW. 2. ALL DRAINAGE WORKS SHALL BE CONSTRUCTED AND STABILIZED AS EARLY AS POSSIBLE DURING DEVELOPMENT.

3. SEDIMENT TRAPS SHALL BE CONSTRUCTED AROUND ALL INLET PITS, 300mm WIDE X 300mm DEEP TRENCH

4. ALL SEDIMENT BASINS AND TRAPS SHALL BE CLEANED WHEN THE STRUCTURES ARE A MAXIMUM OF 60 % FULL OF SOIL MATERIALS, INCLUDING THE MAINTENANCE PERIOD. 5. ALL DISTURBED AREAS SHALL BE REVEGITATED AS SOON AS THE RELEVANT WORKS ARE COMPLETED.

6. SOIL AND TOPSOIL STOCKPILES SHALL BE LOCATED AWAY FROM DRAINAGE LINES AND AREA WHERE WATER MAY CONCENTRATE

7. FILTER SHALL BE CONSTRUCTED BY STRETCHING A FILTER FABRIC (PROPEX OR APPROVED EQUIVALENT BETWEEN POST AT 3.0m CENTRES. FABRIC SHALL BE BURIED 150mm ALONG ITS LOWER EDGE.



MR S. METRY

#### CONSTRUCTION SITE

The subject construction site should implement the following: • The driveway crossings on Melvin Street will be used for

- vehicular access by construction vehicles during the loading/unloading and delivery activities. vehicular access by construction vehicles during the loading/unloading and delive Vehicles are to enter and exit the site in a under supervision where possible, therefore increasing safety for pedestrians and preventing traffic congestion.
   A certified Traffic Controller is to be stationed at the entry/exit driveway, when large construction vehicles arrive/depart to ensure they access the site safely and to manage the flow of traffic and pedestrians near the site.
- All construction vehicles arriving to and leaving the site shall have their demolition/excavation and material loads sealed or covered. The loading of disposable material into these vehicles leaving the site is to occur within the site
- The wheels of construction vehicles are to be cleaned and hosed by construction
- personnel before leaving the site, to ensure that soil and other material is not transported or tracked onto the footpath or the roadway. The truck pathway is to be swept on regular basis to ensure that demolition and construction materials do
- not build up or get transported to public roads and footpaths. All construction vehicles are to ensure that their engines are turned off, where possible, in order to minimise any noise impacts on adjoining properties
- The storage of all building materials and machinery is to take place only within the boundary internation and matching is to due piece only mutual the boundaries of the site in order to protect public roads and footpaths. The storage of building materials or any equipment on the public roadway or footpath is not permitted at all times. Cranes and concrete pumps are to be positioned within the site boundaries or at the front of the site within the dedicated on-road Works Zone, if required and approved by Council. Location of site amenities including site toilet, staff parking and a dedicated area
- for loading and unloading, material, plant and spoil bin storage to be provided within the site
- It should be noted that the locations of site amenities, staff parking, loading and unloading area, waste removal and storage areas may slightly change from time to time, to suit changing conditions of the site for safety and to suit the works methodology. Staff/workers are to utilise the on-site staff parking where possible
- The site manager / leading foreman should ensure that all deliveries and parking where possible. The site manager / leading foreman should ensure that all deliveries and pick-up of construction and waste material is to be adequately staggered with reasonable gaps in time between the arrival and departure of construction vehicles, to avoid multiple vehicles arriving at the same time. Adequate gaps in time between the arrival and departure of construction vehicles is important to allow for possible traffic delays or delays in loading/unloading activities.
- Appropriate sediment control measures are to be installed prior to the Appropriate sediment control measures are to be installed prior to the commencement of any construction works and waste bins are to be placed within the site for the storage of demolished/excavated/waste material, to ensure the safe disposal or recycling and minimising impacts on the environment.
   A temporary 1.8 metre high security fence is to be installed around the site at all times during the proposed works, in order to protect pedestrians and ensure that the site is secured against unauthorised entry or when the site is not attended.
- No unauthorised pedestrians are to be given access to enter the site. Travel within the site is to be confined to designated walkways/areas identified by safety signs and/or temporary fencing. All personnel on site are to wear safety
- equipment including high visibility vers. leveloper is to ensure that there are adequate measures to protect all public roads and footway areas from any damage that may be caused by the construction activities. A Dilapidation report is to be prepared by the developer
- and submitted to Council. The developer is to pay Council for any unintended damage to public areas adjacent to site and to have any damaged areas rectified immediately upon completion of work.

SEDIMENT & EROSION NOTES 1. IMMEDIATELY FOLLOWING SETTING OUT OF THE WORKS, BUT PRIOR TO COMMENCEMENT OF ANY CLEARING OR EARTHWORKS, THE CONTRACTOR AND SUPERINTENDENT SHALL WALK THE SITE TO NOMINATE THE LOCATIONS AND TYPES OF SEDIMENT AND EROSION CONTROL MEASURES TO BE ADOPTED. THESE MEASURES SHALL BE IMPLEMENTED PRIOR TO ANY CLEARING OR EARTHWORKS AND MAINTAINED UNTIL THE WORKS ARE COMPLETED AND NO LONGER POSE AN EROSION HAZARD.

UNILESS OTHERWISE APPROVED BY THE SUPERINTENDENT. 2. IMMEDIATELY FOLLOWING SETTING OUT OF THE WORKS, BUT PRIOR TO COMMENCEMENT OF ANY CLEARING OR EARTHWORKS, THE CONTRACTOR AND SUPERINTENDENT SHALL WALK THE SITE TO IDENTIFY AND MARK TREES WHICH ARE TO BE PRESERVED. NOTWITHSTANDING THE ABOVE,THE CONTRACTOR SHALL TAKE ALL REASONABLE PRECAUTIONS TO MINIMISE DISTURBANCE TO EXISTING VEGETATION AND GROUND COVER OUTSIDE THE MINIMUM AREAS REQUIRED TO COMPLETE THE WORKS AND SHALL BE RESPONSIBLE FOR RECTIFICATION, AT ITS OWN COST, OF ANY DISTURBANCE BEYOND THOSE AREAS. 3. PROVIDE GULLY GRATE INLET SEDIMENT TRAPS AT ALL GULLY PITS.

 A PROVIDE SILT FENCING ALONG PROPERTY LINE AS DIRECTED BY SUPERINTENDENT.
 ADDITIONAL CONTROL DEVICES TO BE PLACED WHERE DIRECTED BY SUPERINTENDENT.
 ALTERNATIVE DESIGNS TO BE APPROVED BY SUPERINTENDENT PRIOR TO CONSTRUCTION.

. WASH DOWN/RUMBLE AREA TO BE CONSTRUCTED WITH PROVISIONS RESTRICTING ALL SILT AND TRAFFICKED DEBRIS FROM ENTERING THE STORMWATER SYSTEM. 8. NO WORK OR STOCKPILING OF MATERIALS TO BE PLACED OUTSIDE OF SITE WORK BOUNDARY.

9. APPROPRIATE EROSION AND SEDIMENT CONTROLS TO BE USED TO PROTECT STOCKPILES AND MAINTAINED THROUGH OUT CONSTRUCTION. 10. IT IS THE CONTRACTORS RESPONSIBILITY TO TAKE DUE CARE OF NATURAL

VEGETATION. NO CLEARING IS TO BE UNDERTAKEN WITHOUT PRIOR APPROVAL FROM THE SUPERINTENDENT. 11. TO AVOID DISTURBANCE TO EXISTING TREES, EARTHWORKS WILL BE MODIFIED AS

DIRECTED ON-SITE BY THE SUPERINTENDENT

12. THE LOCATION OF EROSION AND SEDIMENTATION CONTROLS WILL BE DETERMINED ON SITE BY THE SUPERINTENDENT. 13. ACCESS TRACKS THROUGH THE SITE WILL BE LIMITED TO THOSE DETERMINED BY THE

SUPERINTENDENT AND THE CONTRACTOR PRIOR TO ANY WORK COMMENCING. 14. ALL SETTING OUT IS THE RESPONSIBILITY OF THE CONTRACTOR PRIOR TO WORKS COMMENCING ON SITE. THE SUPERINTENDENT'S SURVEYOR SHALL PEG ALL ALLOTMENT BOUNDARIES. PROVIDE COORDINATE INFORMATION TO THESE PEGS AND PLACE BENCH MARKS. THE CONTRACTOR SHALL SET OUT THE WORKS FROM AND MAINTAIN THESE PEGS.

15. PLANS ARE MINIMUM REQUIREMENTS AND ARE TO BE USED AS A GUIDE ONLY. EXACT MEASURES USED SHALL BE DETERMINED ON SITE IN CONJUNCTION WITH PROGRAM O CONTRACTORS WORKS etc.

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SCALE 1:50@ A1	DATE 16/02/2023
1:100@ A3	
0 1 2	3 4 5m

SEDIMENT & EROSION PLAN

WINDOW SCHEDULE												
Front View												
ID	WD -01	WD -02	WD -03	WD -04	WD -05	WD -06	WD -07	WD -08	WD -09	WD -10	WD -11	WD -12
Floor (Story)	Ground Floor	First Floor	First Floor	First Floor	First Floor	First Floor	First Floor					
Frame Height	900	1,200	1,200	1,200	1,200	1,200	2,100	2,100	600	600	900	900
Frame Width	600	1,321	1,500	1,500	1,000	2,000	600	700	1,500	1,500	1,200	1,200
Head Height	3,293	3,293	2,400	2,400	2,400	3,293	2,100	2,100	2,400	2,400	2,400	2,400
Quantity	1	1	1	1	1	1	1	1	1	1	1	1
					WIN	DOW SCHEDUI	_E	1	1	1	1	
Front View												
ID	WD -13	WD -14	WD -15	WD -16	WD -17	WD -18	WD -19	WD -20	WD -21	WD -22	WD -23	WD -24
Floor (Story)	First Floor	Second Floor	Second Floor	Second Floor	Second Floor	Second Floor	Second Floor	Second Floor				
Frame Height	600	600	2,100	500	2,100	900	900	900	600	2,100	2,100	2,100
Frame Width	1,400	1,500	700	1,000	700	600	600	600	1,165	700	700	700
Head Height	2,400	2,400	2,210	2,847	2,245	2,100	2,100	2,100	2,400	2,100	2,100	2,100
Quantity	1	1	1	1	1	1	1	1	1	1	1	1
					WINDOW S	CHEDULE				•		
Front View												
ID	WD -25	WD -26	WD -27	WD -28	WD -29	WD -30	WD -31	WD -32	WD -33	+		
Floor (Story)	Second Floor	Ground Floor	Ī									
Frame Height	600	2,100	2,100	500	2,100	2,100	600	600	2,989			
Frame Width	1,500	700	700	1,000	700	700	1,400	1,400	900			
Head Height	2,400	2,100	2,100	2,400	2,100	2,049	2,400	2,400	2,989			
Quantity	1	1	1	1	1	1	1	1	8			



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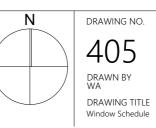
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CLIENT MR S. METRY STATUS DA STAGE

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